

ADDENDUM NO. 1

**GREATER DAYTON RECREATION CENTER PARKING LOT EXPANSION
(10% MBE AND 15% HUD SECTION 3 PARTICIPATION GOAL)
(FEDERAL CDBG FUNDS)
JULY 23, 2018**


TO ALL BIDDERS:

This addendum, including all articles and corrections listed below, shall be taken into account in preparing the bid forms and shall become part of the Contract.

All bidders are requested to attach this Addendum to the Bid Form and return to the City.

ITEM NO. 1 – SUBSTITUTE DRAWING SHEETS

Substitute the following attached Drawing Sheets in their entirety: CT2 & CT4. Drawing Sheet CT2 removed language regarding the installation of ADA truncated domes and Drawing Sheet CT4 changed the vertical curb height from 18” to 20”.

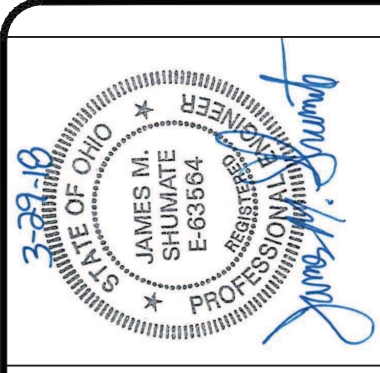

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NO	REVISION	DATE
1	CITY OF DAYTON DEPARTMENT OF WATER PLANS REVIEW COMMENTS	03-19-18

SCALE:	1" = 30'
DATE:	02/20/18
DESIGNED BY:	EODS
DRAWN BY:	EODS
CHECKED BY:	JSHU

GREATER DAYTON
RECREATION CENTER
PARKING LOT
LAYOUT AND UTILITY PLAN

PROJECT NO:	P170418
DRAWING NAME	C2
SHEET	2
OF	11

GREATER DAYTON RECREATION CENTER

CONSTRUCTION NOTES

- 20" VERTICAL CONCRETE CURB - SEE DETAIL SHEET C4
- SAWCUT EXISTING PAVEMENT TO CLEAN EDGE - SEAL EDGE WITH NEW PAVEMENT
- EXISTING CONCRETE SIDEWALK TO BE REMOVED
- PROPOSED CONCRETE SIDEWALK - SEE DETAIL SHEET C4
- CONCRETE FLUME CONSTRUCT 2" WIDE OPENING IN CURB FOR DRAINAGE - SEE DETAIL SHEET C4
- PROPOSED CONCRETE DRIVEWAY APRON - SEE DETAIL SHEET C4 - SAW CUT AND REMOVE EXISTING CONCRETE CURB AND SIDEWALK CONSTRUCT CONCRETE DROP CURB AND CONCRETE APRON
- REMOVE EXISTING INLET - REPLACE WITH PROPOSED DOUBLE GUTTER INLET AND WINDOW OPENING - GRATE ONLY - SEE DETAIL SHEET C4
- EXISTING UTILITY POLE TO BE RELOCATED BY RTA. COORDINATE WORK WITH UTILITY OWNER (RTA) TO BE CONSIDERED INCIDENTAL TO THE CONTRACT AND NO ADDITIONAL PAYMENT WILL BE MADE.
- NOT USED
- ADJUST EXISTING CATCH BASIN TOP TO PROPOSED GRADE
- REMOVE EXISTING PAVEMENT - SEE SHEET C1 FOR DEMOLITION LIMITS
- PROPOSED FENCE - SEE LANDSCAPING SHEETS FOR DETAILS
- UNDERDRAIN - CONNECT TO OUTFALL STRUCTURE - SEE DETAIL SHT C4
- EXISTING TREE STUMP AND TREE TO BE REMOVED. CONSTRUCT NEW SIDEWALK IN THE EXISTING TREE PLANTERS PER DETAIL SHT. C4.
- RE-STRIP SPACES TO PROVIDE 5 A.D.A. COMPLIANT SPACES W/ PAVEMENT MARKINGS AND SIGNS PER DETAIL SHT. C4
- CONTRACTOR TO LOCATE EXISTING UTILITIES AT LOCATION OF EXISTING CATCH BASIN AND EXISTING STORM MANHOLE. ANY POTENTIAL CONFLICT WITH EXISTING UTILITIES SHALL BE REPORTED TO THE CITY ENGINEERS OFFICE AND CT CONSULTANTS PRIOR TO CONSTRUCTION.

SYMBOL LEGEND

EXISTING LANDSCAPING

EXISTING FENCE

EXISTING SANITARY MANHOLE

EXISTING SANITARY SEWER

EXISTING FIRE HYDRANT

EXISTING WATER METER

EXISTING WATER VALVE

EXISTING WATER LINE

EXISTING STORM SEWER

EXISTING CURB INLET

EXISTING CATCH BASIN

EXISTING STORM MANHOLE

EXISTING GAS MAIN

EXISTING UTILITY POLE

PROPOSED ASPHALT PAVEMENT - SEE DETAIL SHT. C4

PROPOSED STORM SEWER AND STRUCTURE


PROPOSED UNDERDRAIN - SEE DETAIL SHT. C4

PROPOSED FENCE - SEE LANDSCAPE SHEETS FOR DETAILS

PROPOSED CONCRETE VERTICAL CURB - SEE DETAIL SHT. C4


PROPOSED CONCRETE APRON PER CITY OF DAYTON STANDARD DWG - SEE DETAIL SHT. C4

PROPOSED CONCRETE SIDEWALK - SEE DETAIL SHT. C4

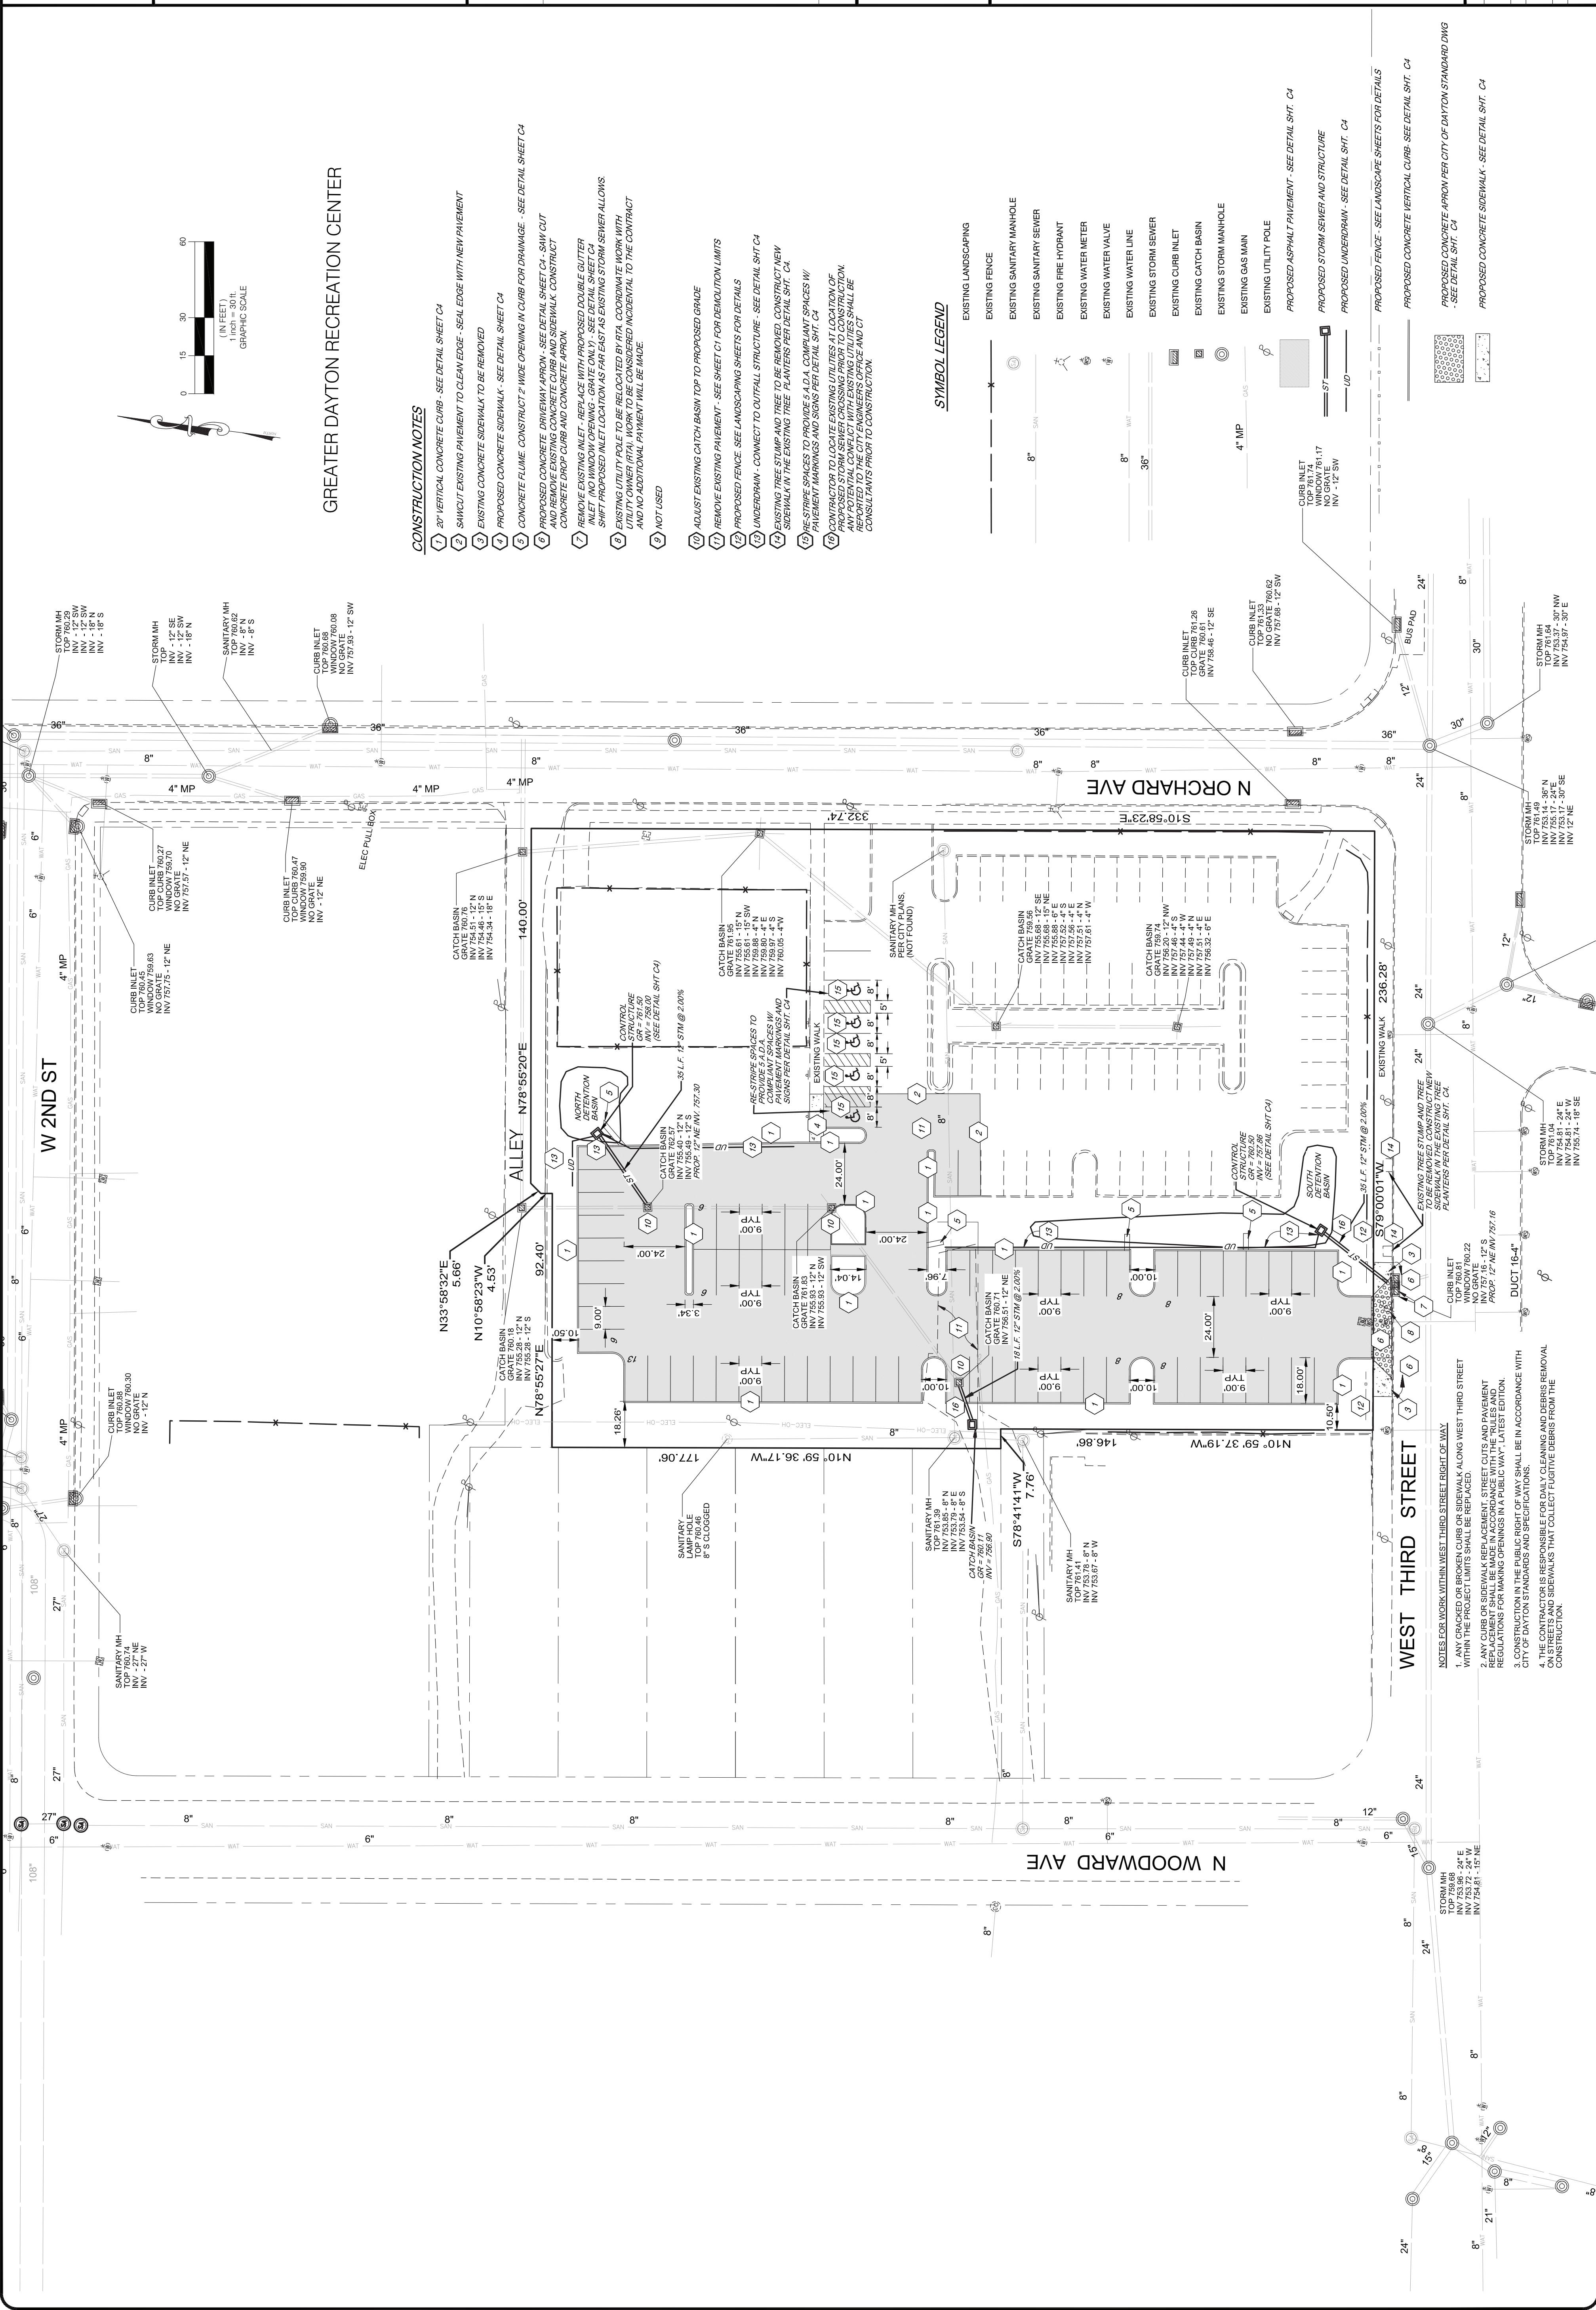

WEST THIRD STREET

- NOTES FOR WORK WITHIN WEST THIRD STREET RIGHT OF WAY:
- ANY CRACKED OR BROKEN CURB OR SIDEWALK ALONG WEST THIRD STREET WITHIN THE PROJECT LIMITS SHALL BE REPLACED.
 - ANY CURB OR SIDEWALK REPLACEMENT, STREET CUTS AND PAVEMENT REPAIRS SHALL BE IN ACCORDANCE WITH THE CITY OF DAYTON STANDARD SPECIFICATIONS.
 - CONSTRUCTION IN THE PUBLIC RIGHT OF WAY SHALL BE IN ACCORDANCE WITH CITY OF DAYTON STANDARDS AND SPECIFICATIONS.
 - THE CONTRACTOR IS RESPONSIBLE FOR DAILY CLEANING AND DEBRIS REMOVAL ON STREETS AND SIDEWALKS THAT COLLECT FUGITIVE DEBRIS FROM THE CONSTRUCTION.

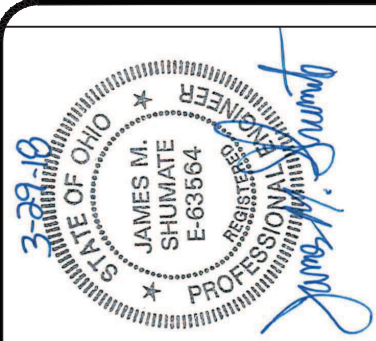

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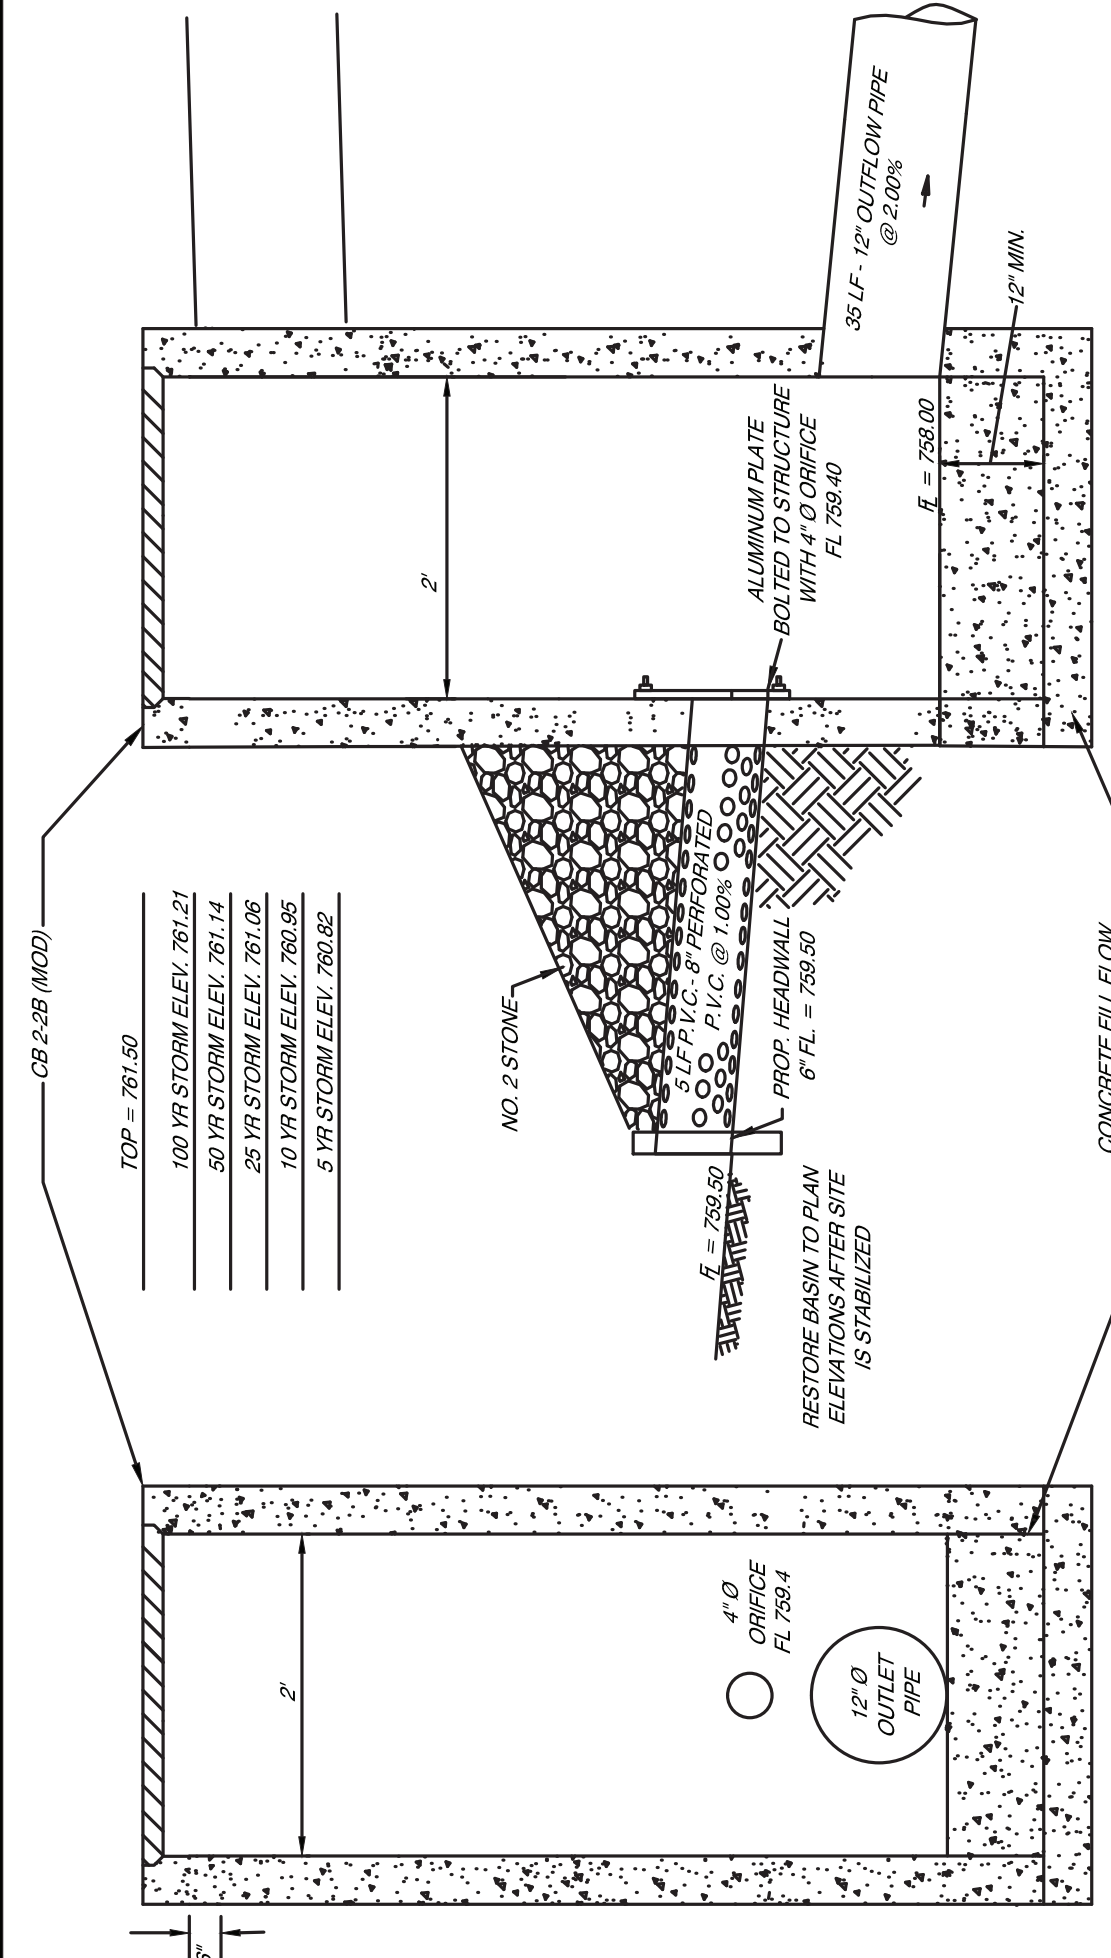
NO.	REVISION	DATE
1	CITY OF DAYTON REVIEW COMMENTS	03-29-18
2		
3		
4		
5		
6		
7		
8		
9		
10		

DESIGNED BY: EODS	DATE: 02/20/18	CHECKED BY: JSU
DRAWN BY: EODS		

SCALE: 1" = 30'


GREATER DAYTON
RECREATION CENTER
PARKING LOT
DETAILS

PROJECT NO:	P170418
DRAWING NAME	RECREATION CENTER PARKING LOT
CAD	
SHEET	4
OF	11




OUTLET CONTROL STRUCTURE FOR NORTH BASIN

NOTE FOR BOTH STRUCTURES:
ONCE THE SITE HAS BEEN FULLY STABILIZED, THE CONTRACTOR SHALL REMOVE THE ACCUMULATED SEDIMENT IN THE SEDIMENT DETENTION BASIN AND SHALL REESTABLISH THE ORIGINAL GRADATION FOR THE DETENTION BASIN. THE SEDIMENT SHALL THEN BE REMOVED AND THE WATER OUTLET FEATURE (8" PERFORATED PIPE AND NO. 2 STONE) SHALL BE INSTALLED PER THE DETAIL.

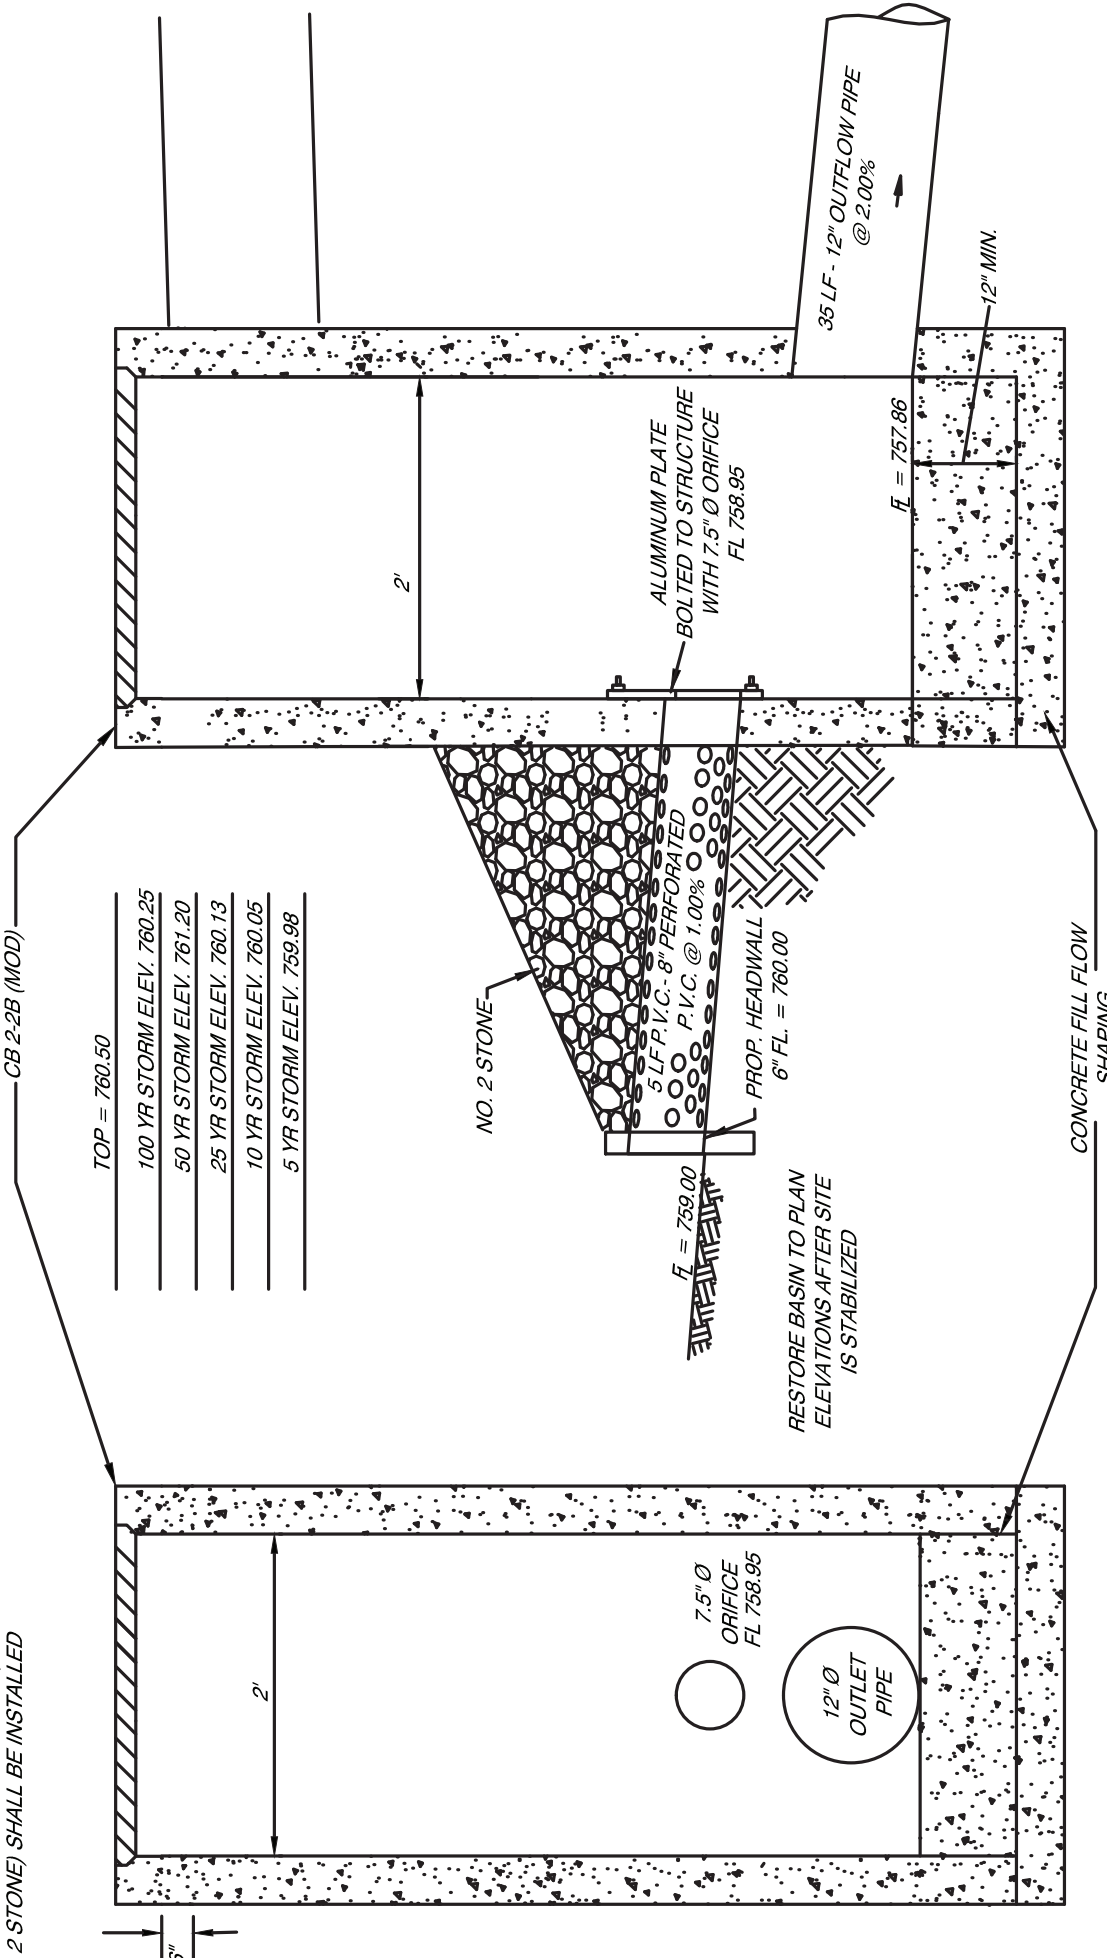


OUTLET CONTROL STRUCTURE FOR SOUTH BASIN

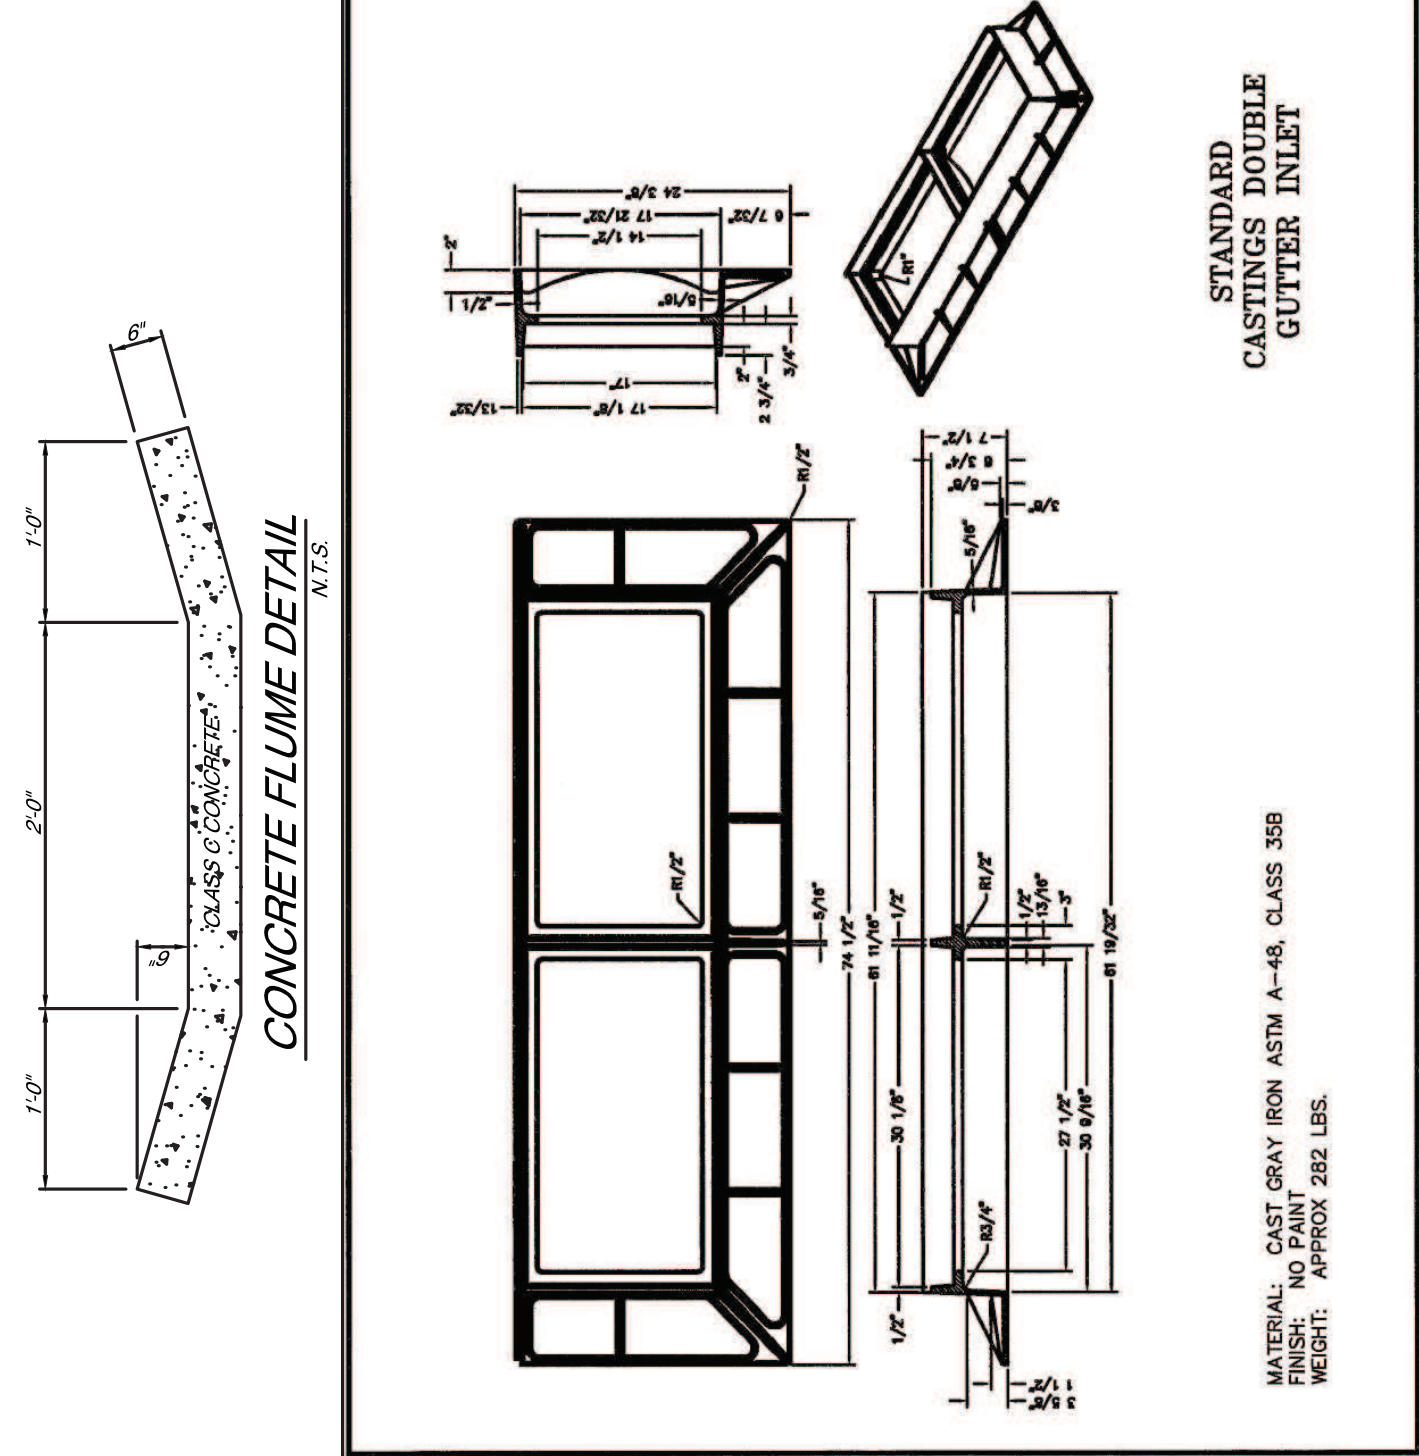


STANDARD CASTINGS DOUBLE GUTTER INLET

MATERIAL: CAST GRAY IRON ASTM A-48, CLASS 35B
FINISH: NO PAINT
WEIGHT: APPROX 282 LBS.

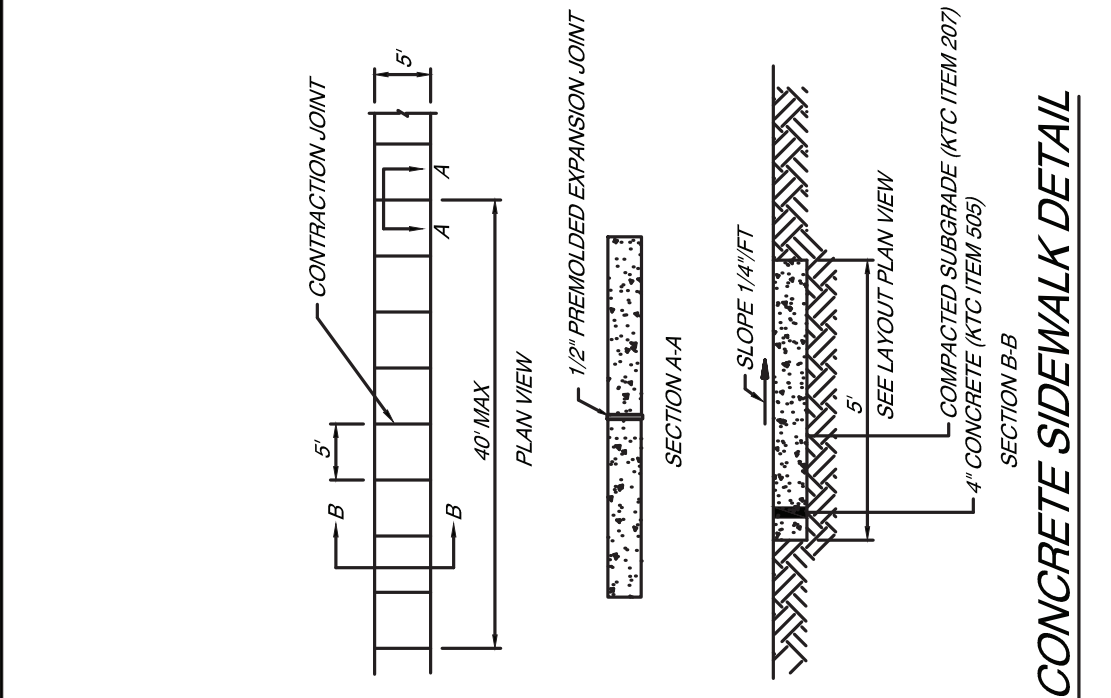


CONCRETE SIDEWALK

NOTE FOR BOTH STRUCTURES:
ONCE THE SITE HAS BEEN FULLY STABILIZED, THE CONTRACTOR SHALL REMOVE THE ACCUMULATED SEDIMENT IN THE SEDIMENT DETENTION BASIN AND SHALL REESTABLISH THE ORIGINAL GRADATION FOR THE DETENTION BASIN. THE SEDIMENT SHALL THEN BE REMOVED AND THE WATER OUTLET FEATURE (8" PERFORATED PIPE AND NO. 2 STONE) SHALL BE INSTALLED PER THE DETAIL.

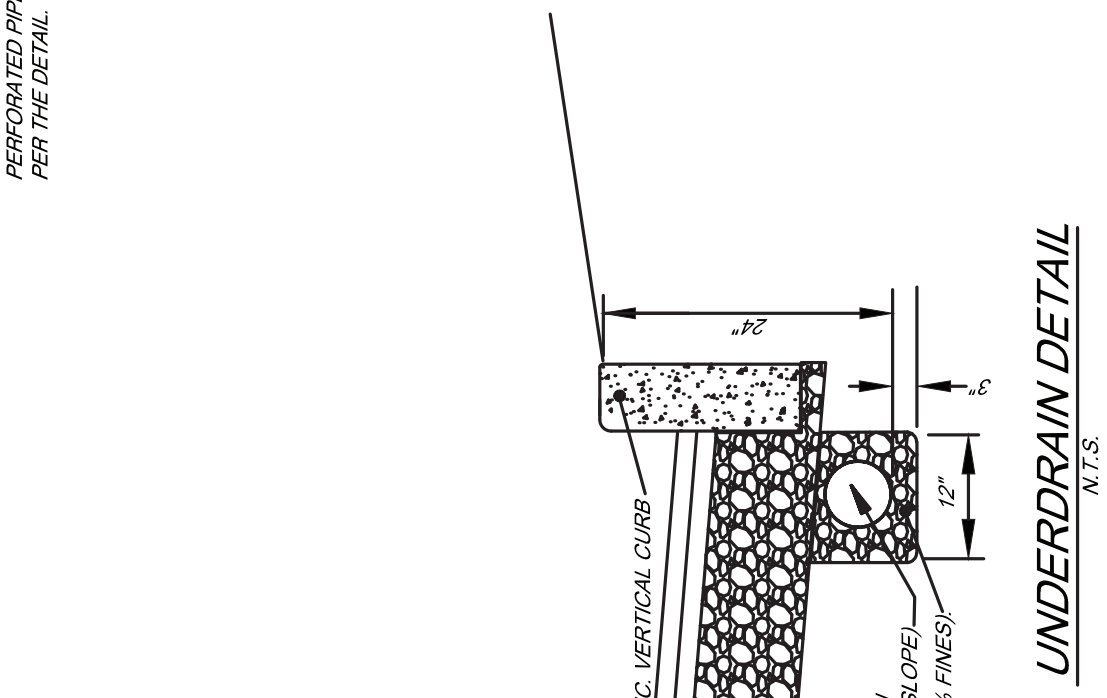


UNDERDRAIN

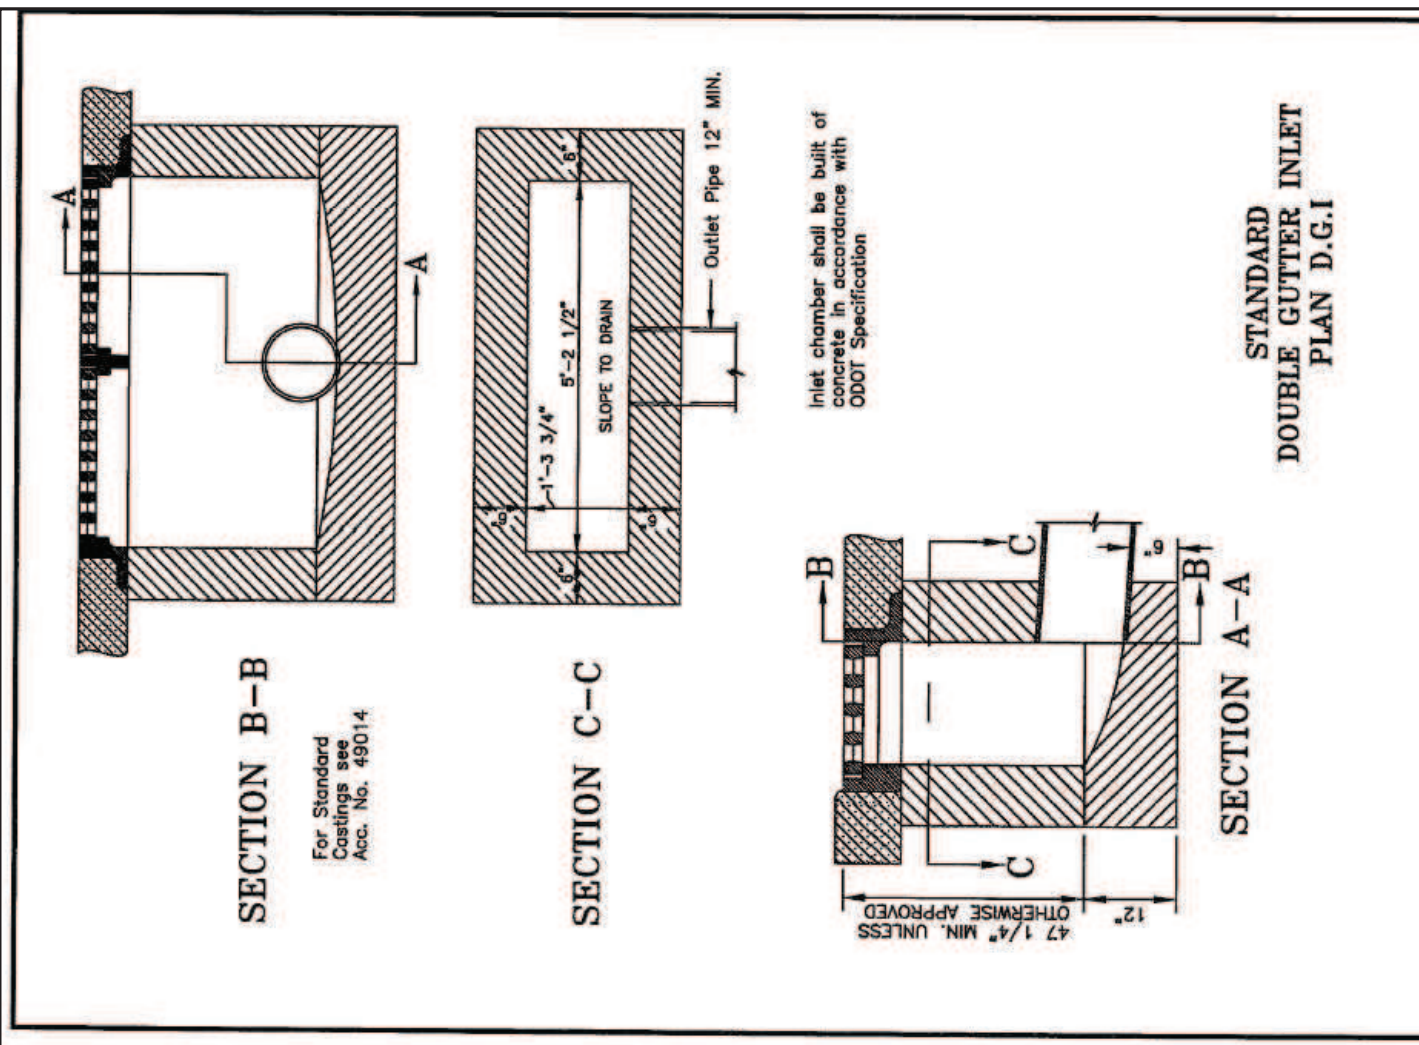

STANDARD DOUBLE GUTTER INLET

MATERIAL: CAST GRAY IRON ASTM A-48, CLASS 35B
FINISH: NO PAINT
WEIGHT: APPROX 282 LBS.

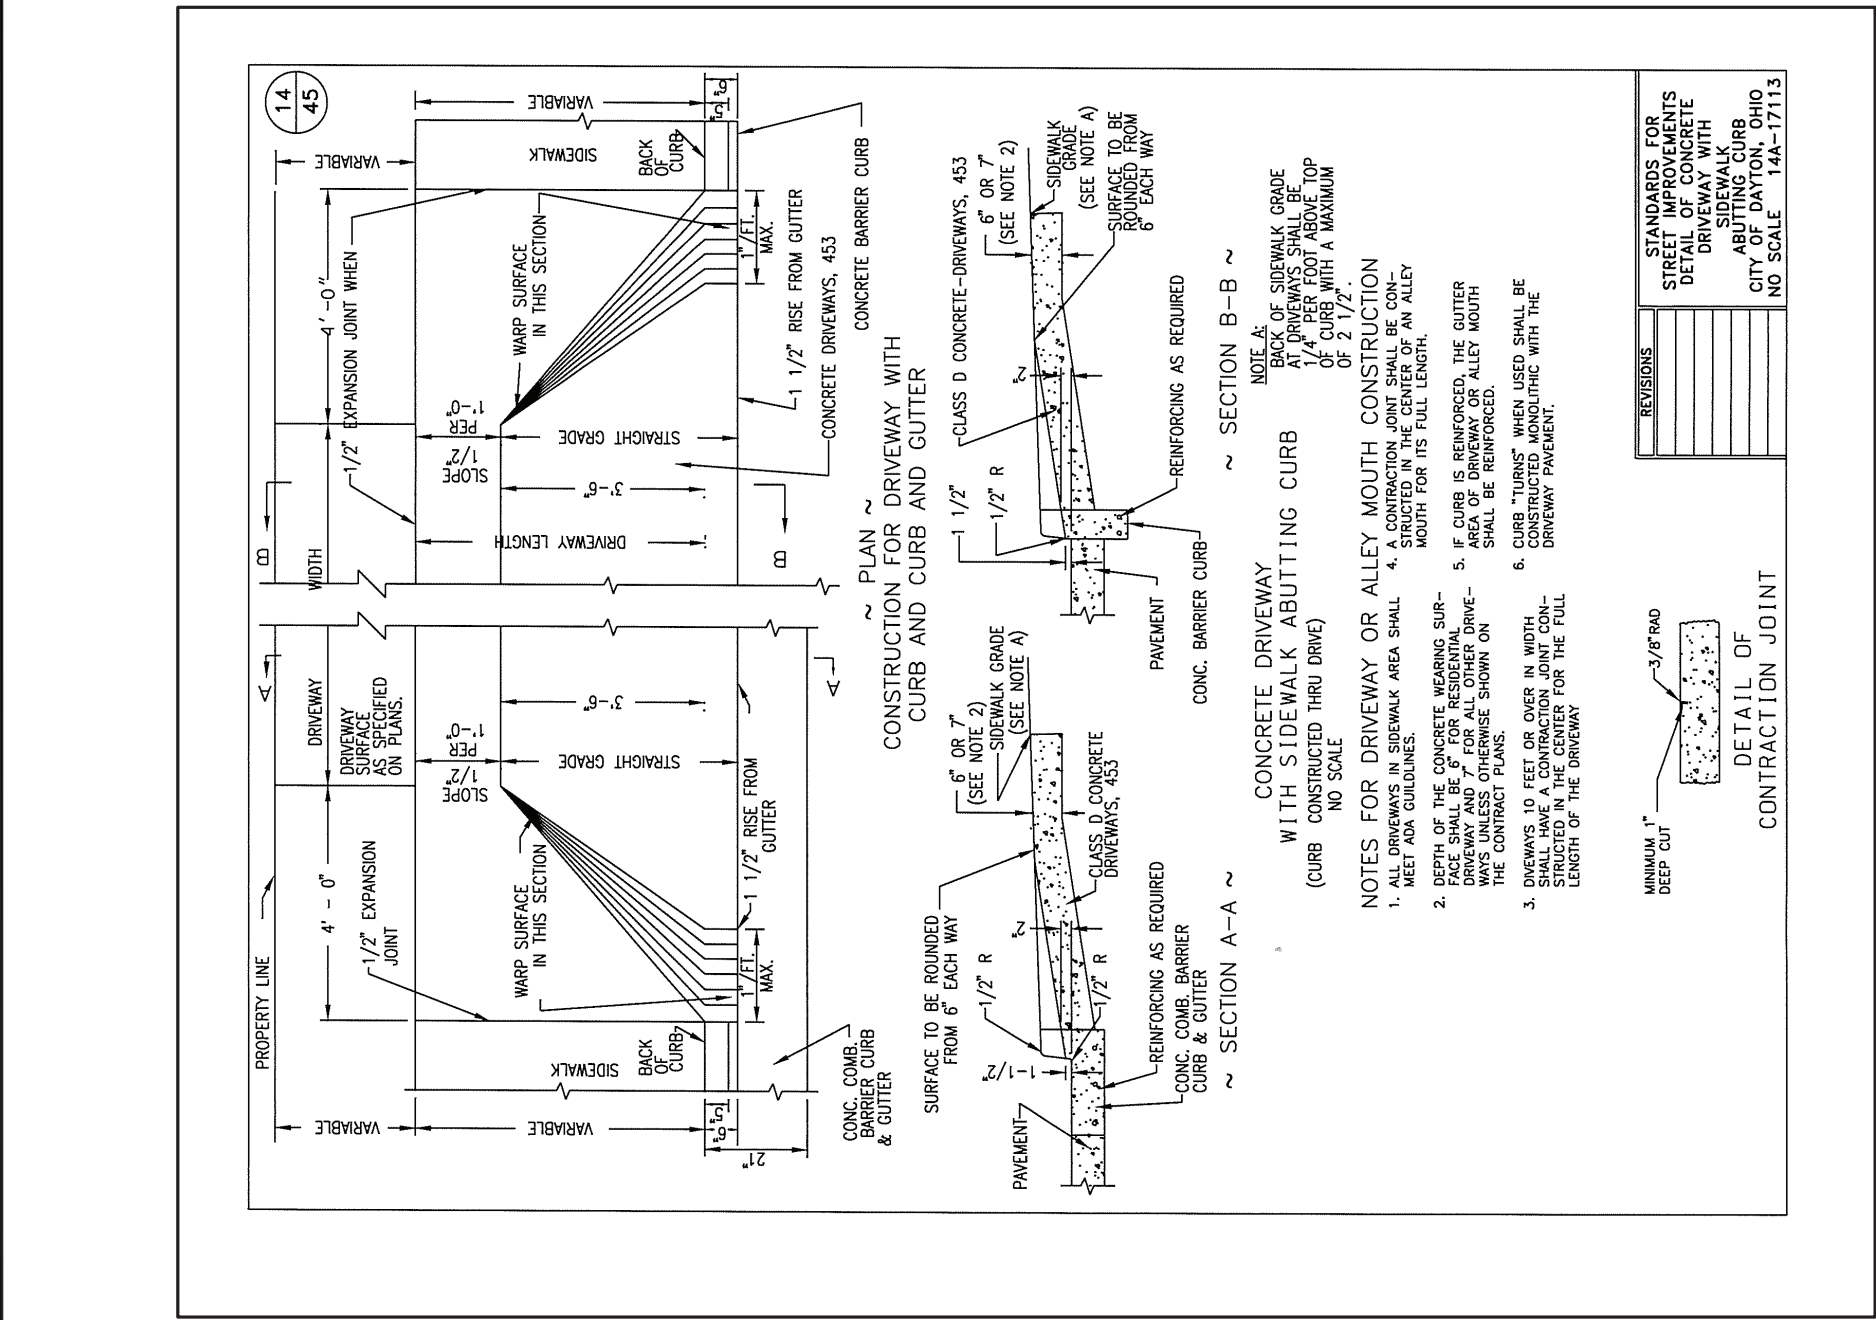


CATCH BASIN NO. 2-2A & B

SECTION A-A

SECTION B-B

SECTION C-C

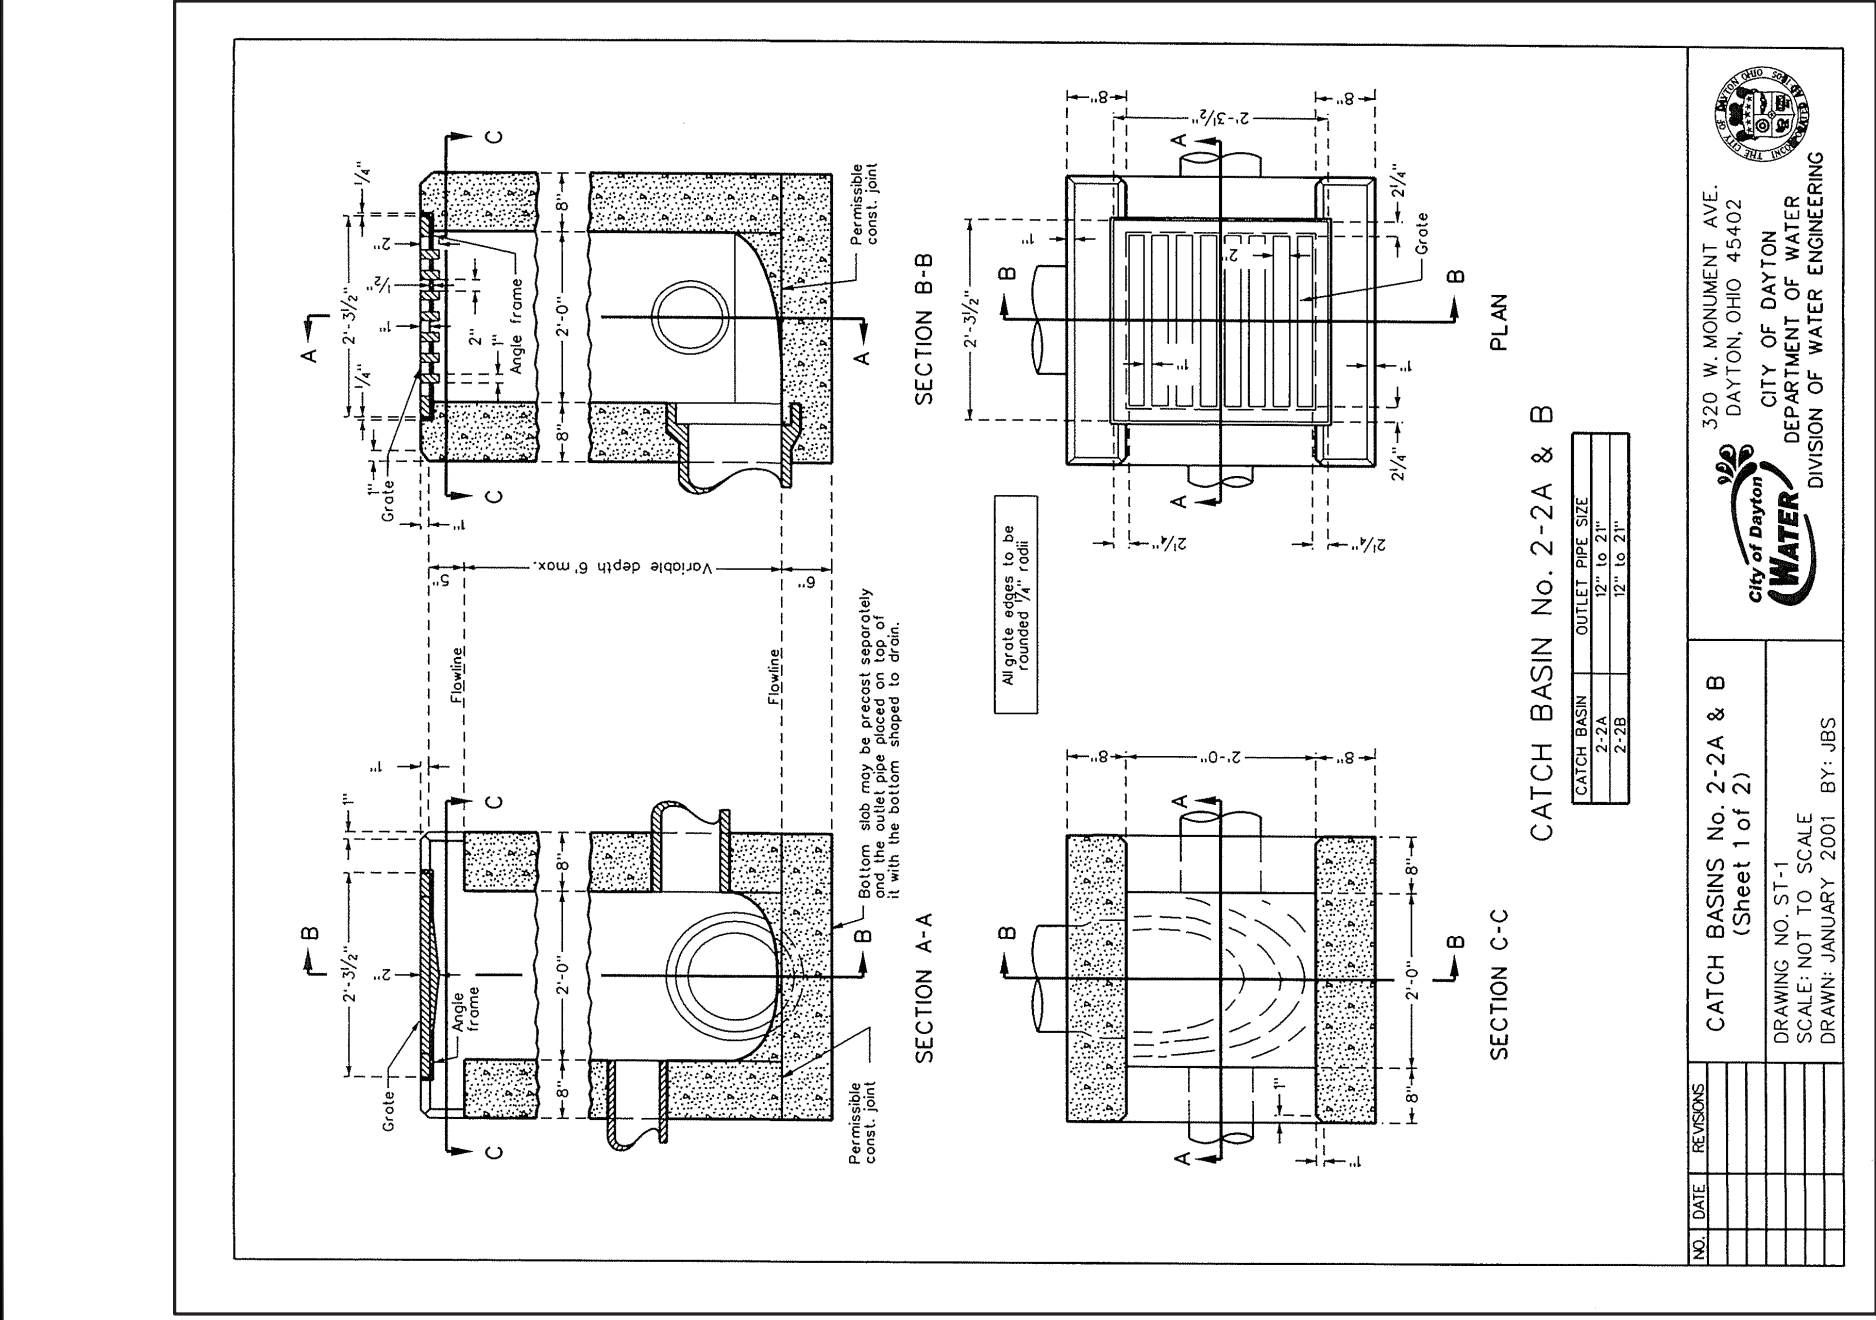


CATCH BASIN NO. 2-2A & B

SECTION A-A

SECTION B-B

SECTION C-C

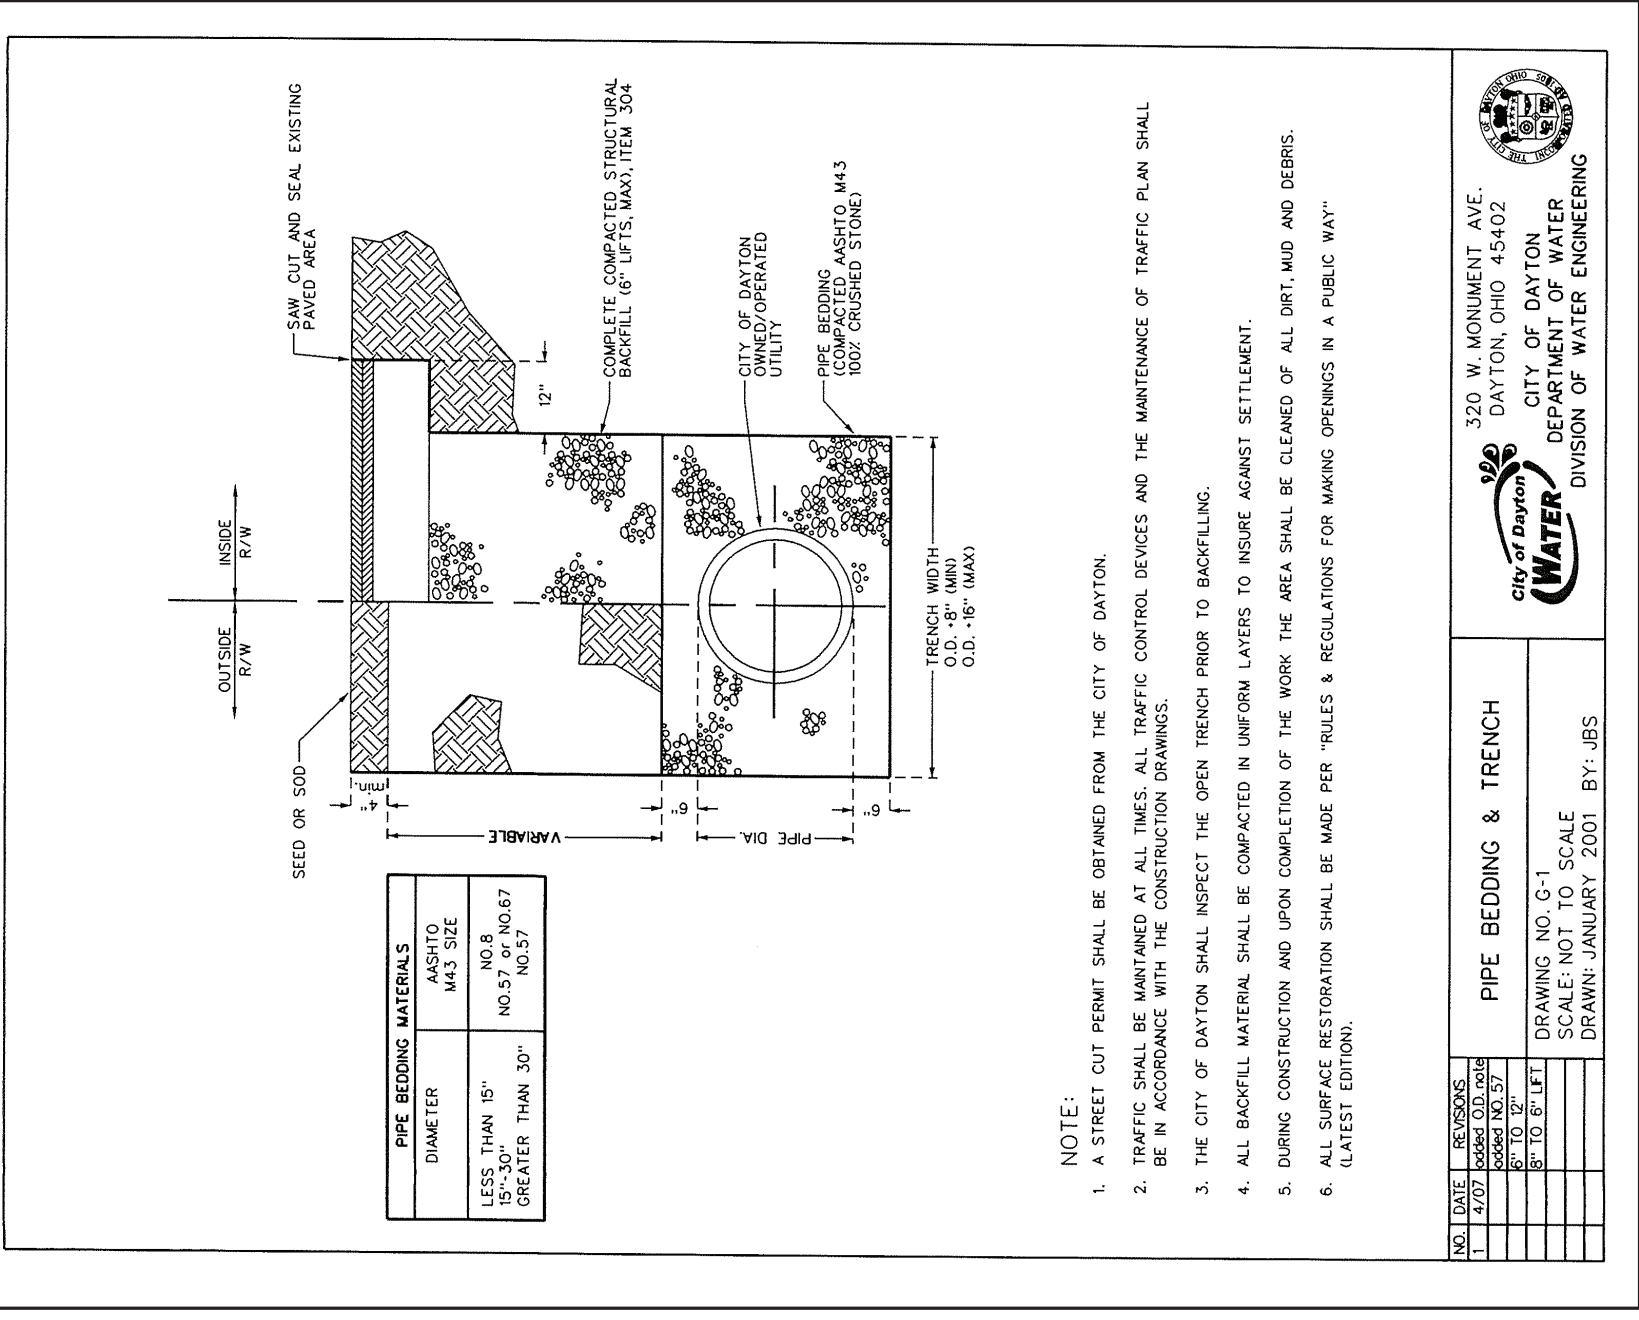


HANDICAPPED PARKING SIGN AND PAVEMENT DETAIL

N.T.S.

HANDICAPPED PARKING SIGN DETAIL

N.T.S.

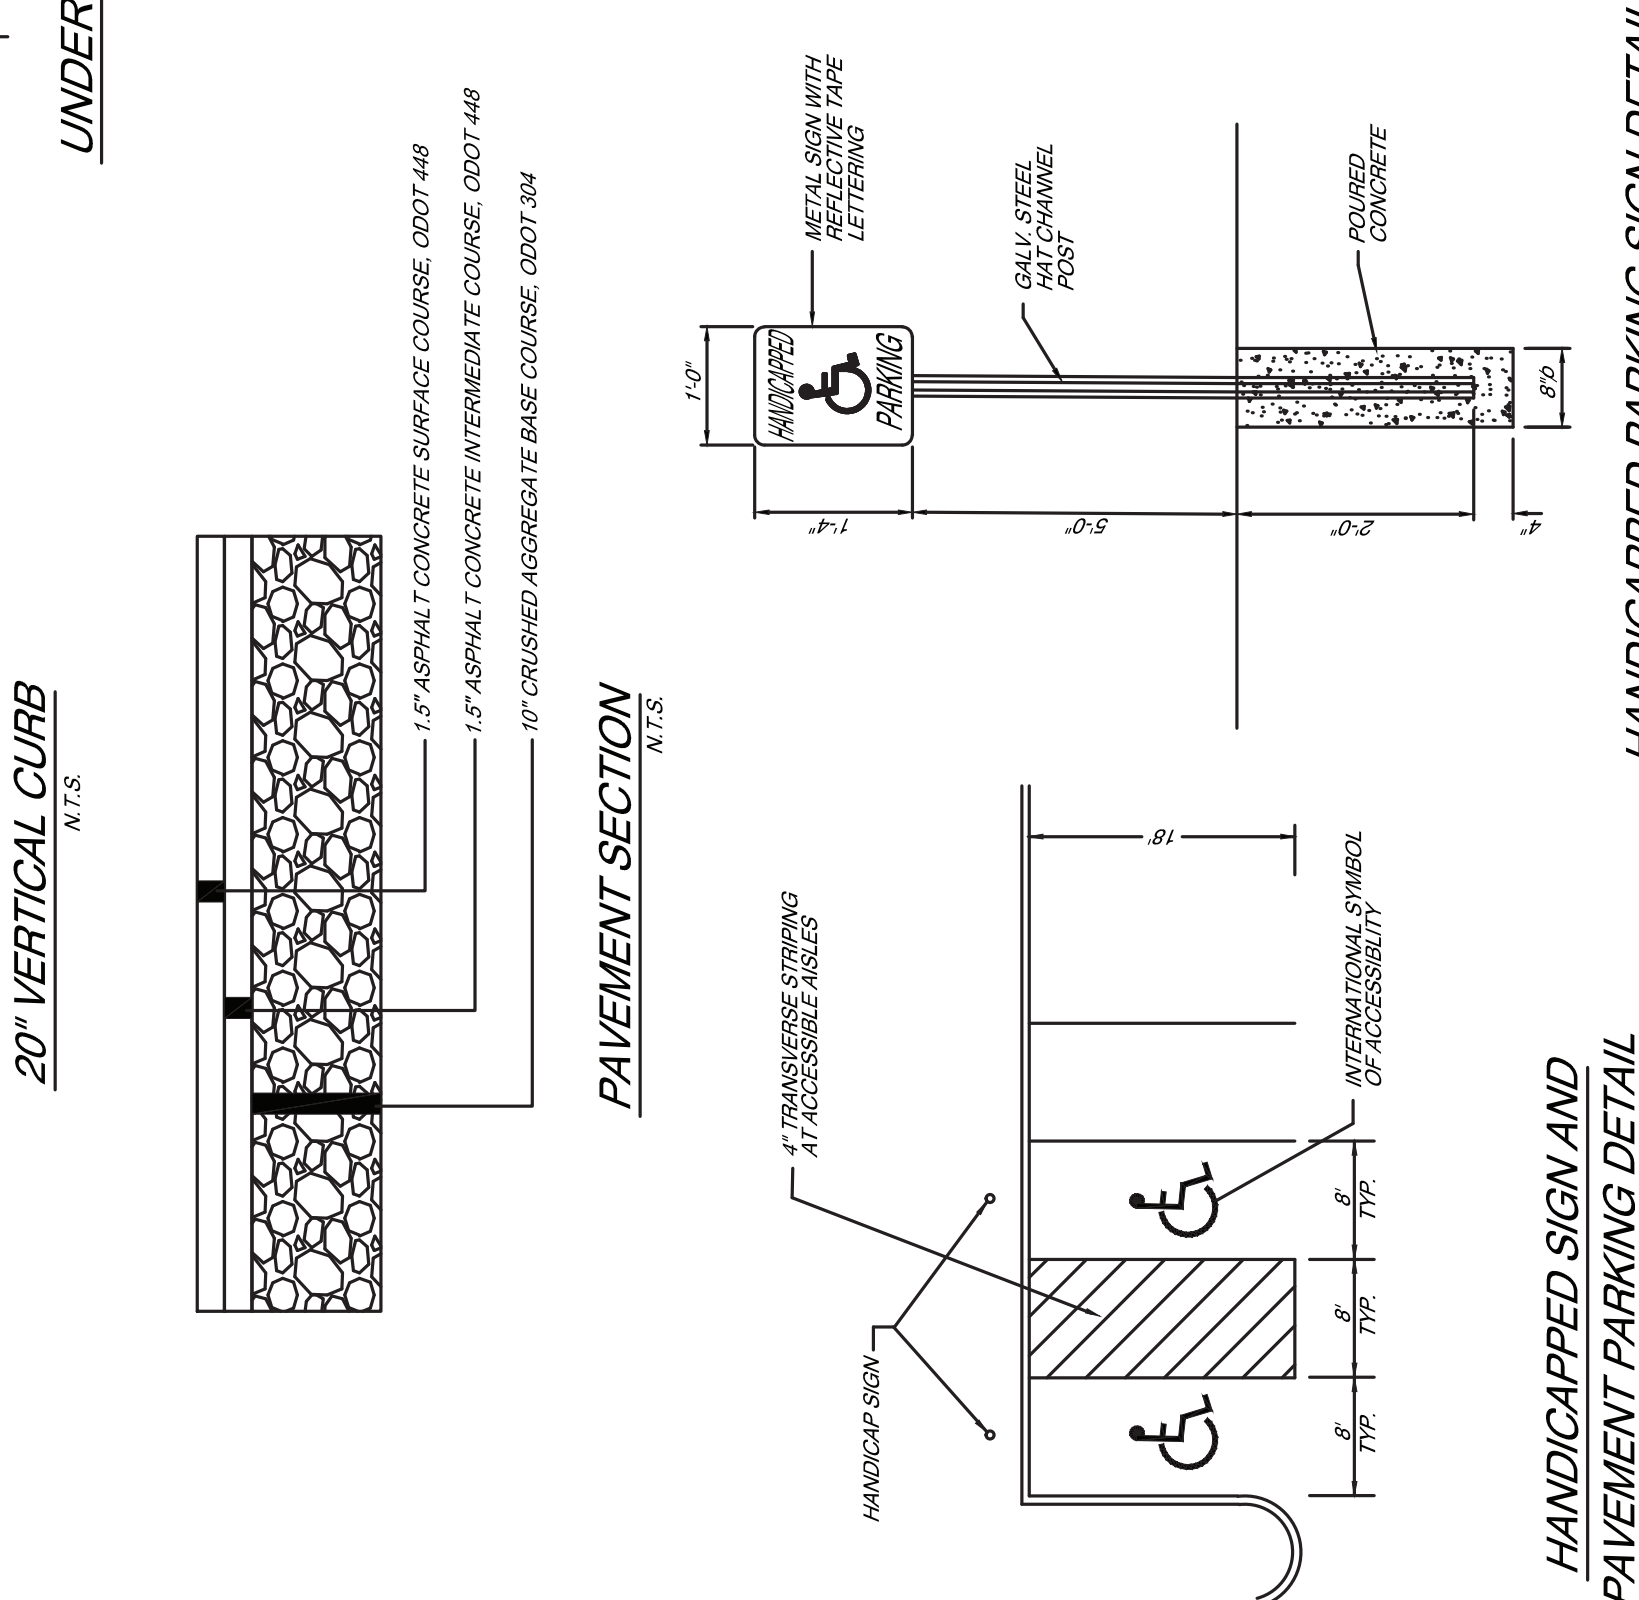

HANDICAPPED PARKING SIGN AND PAVEMENT DETAIL

N.T.S.

HANDICAPPED PARKING SIGN DETAIL

N.T.S.